Site Plan

Windows within pool zone to be Permanently modified not to open greater than 100mm or a security grill to be fitted. Note Key locks do not comply and modifications of doors are not allowable

Pool Equipment Existing Retaining wall Sewer riser GL33.414 Vertical blade tube pool fence -2000mm **GL-500** -500 TOW Retaining wall to be fitted 34.5 post pool installation by client PL 33.914 at 33.94 0.80m-250mm C-BOND Boundary fence H 1800 PLUS 00. -1000mm -1c C-bond GL 33.914 H 1800 Frameless glass Vacant fence and gate **Block EXISITING RESIDENCE** FFL 34.00 EAST FREMANTLE ToebniW

FACTORY POOLS PERTH BEST PRICES GUARANTEED


Plan by Don Del Borrello




5/05/2022

LOT9

Scale 1:200

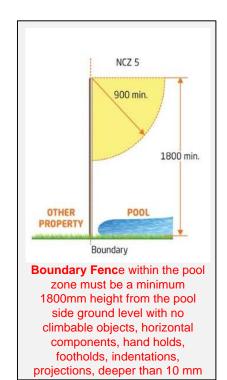

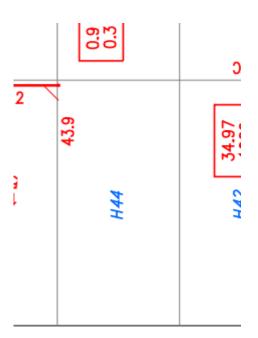

Pool equipment location As per plan and tbc with client
Estimated install date Week commencing
Top of pool to be level with Verandah minus capping thickness

All Machinery allowances are subject to final say by site Supervisor

Owner to supply access for machinery to excavate. Eg remove and replace a fence panel or gate

Pool Equipment needs to be located minimum 3.5mts from the pool waterline and no further than 10mts from the deep end.


Note with Pool equipment fitting. Pavers may need to be lifted or concrete cut at cost. Restoring/replacing is owners responsibility


Client name..

Signature.....

Note With changes to plan after Applications have been approved. Additional charges will apply from \$500 to \$1500.00 $\,$


Proposed pool for Kylie & Dean Cuthbert Model/Type Hampton 8m x 4m Site Address 44 WINDSOR Road, EAST FREMANTLE 6158 Machinery allowance via Drive Suggested Crane Allowance and location to be confirmed From vacant block

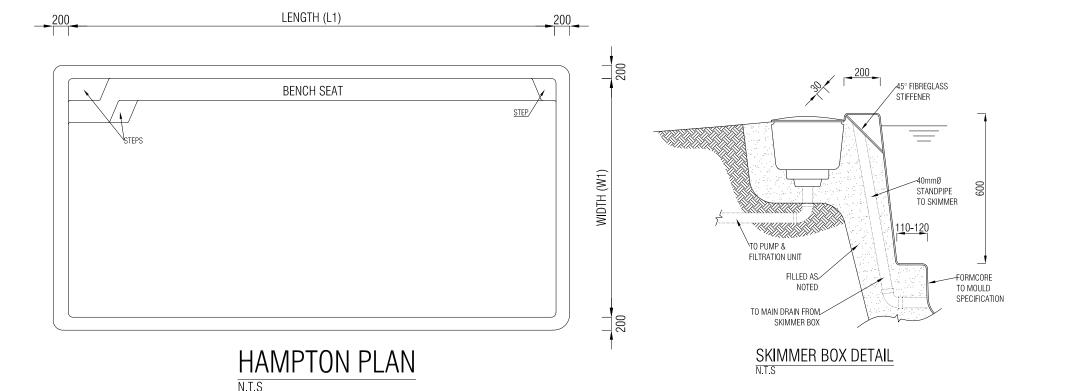


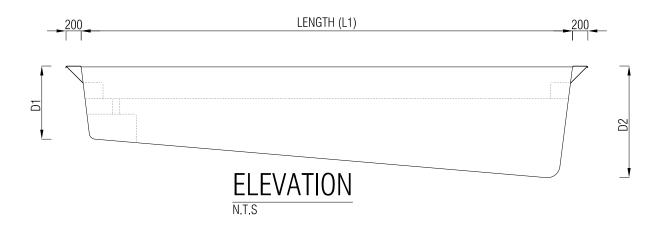

HAMPTON RANGE								
P00L	LENGTH (L1)	WIDTH (W1)	MIN DEPTH (D1)	MAX DEPTH (D2)				
6m Hampton 6000		4000	1150	1730				
7m Hampton	7m Hampton 7000		1150	1850				
8m Hampton	8000	4000	1150	1930				

^{*} All measurements are mm.

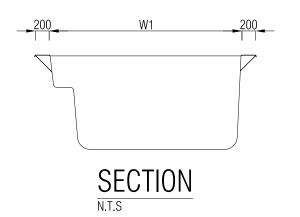

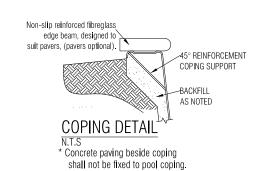

GENERAL NOTES

- PROVIDE A 100mm (min) THICK BEDDING LAYER OF NON-COHESIVE PERMEABLE MATERIAL (max) SIZE 12mm.
- 2. WORK TO COMPLY WITH AS1838 SAA PREMOULDED REINFORCED PLASTIC SWIMMING POOLS & AS1839-1994 SWIMMING POOLS PREMOULDED FIBRE-REINFORCED PLASTICS INSTALLATION & THE REQUIREMENTS OF ALL THE RELEVANT STATUTORY AUTHORITIES.
- THE GRANULAR BASE SHALL BE SCREEDED & COMPACTED TO PROVIDE UNIFORM SUPPORT FOR THE SHELL. PLACE GRAVEL, PLUG, LEVEL THE POOL, HANDLING WITH A CENTRE SPREADER.
- 4. BEDDING TO BE RAMMED BETWEEN SHELL & EXCAVATION IN LAYERS WHEN POOL HAS BEEN FILLED, COMPLETE THE SURROUND.
- THE FIBREGLASS SHELL SHALL HAVE A MINIMUM THICKNESS OF 5mm WITH 3 LAYERS OF 0.025 LBS/FT ROVINGS.
- 6. THE FLOOR SHALL HAVE 3 LAYERS OF CHOP STRAND FIBREGLASS.
- 7. THE RIBS SHALL HAVE 1 LAYER OF 600gr/m².
- 8. ROVINGS OVER RIBS FORMS & LAMINATED TO POOL WALLS.
- 9. RESIN TO GLASS RATIO 2.25:1 BY WEIGHT.
- 10. COPING TO BE 10mm (min) THICKNESS.
- FILTER TO BE CONNECTED TO SKIMMER BOX & WATER RETURN PORTS WITH 40mmØ PVC PRESSURE PIPE & FITTINGS, FIT UP TO HYDROSTATIC VALVE, RETURN PIPES SHALL BE 50mmØ.
- 12. NO RESPONSIBILITY WILL BE TAKEN BY THE CONSULTING ENGINEER FOR DIMENSIONS OBTAINED BY SCALING THE STRUCTURAL DRAWINGS.
- 13. THE CONTRACTOR SHALL BE RESPONSIBLE FOR MAINTAINING THE STRUCTURE AND NEIGHBOURING STRUCTURES IN A SAFE AND STABLE CONDITION DURING CONSTRUCTION. NO PART SHALL BE OVERSTRESSED.
- 14. THIS POOL IS NOT INTENDED FOR USE ON ABOVE GROUND INSTALLATIONS OR DESIGNED TO BE EMPTIED WITHOUT THE APPROVAL OF THE POOL MANUFACTURER.
- 15. THIS POOL IS SUITABLE FOR SOIL CLASSIFICATIONS OF 'A' & 'S' SITES.

	DRAWING REVISIONS		RE	FERENCE DRAWINGS	COPYRIGHT	
						THESE DESIGNS, PI AND INFORMATION
						NOT TO BE USED
						REPRODUCED WHO
<u> </u>	DEVICED TO CUIT OF IENTO DECLIFOR	045	1441/ 0000			USED ON ANY PRO-
С	REVISED TO SUIT CLIENTS REQUEST	GAB	MAY 2022			PERMISSION OF
В	REVISED TO SUIT CLIENTS REQUEST	GAB	MAR 2022			SUMMERMORE PTY
	PRELIMINARY FOR CLIENTS APPROVAL	GAB	NOV 2021			DO NOT SCALE FR
REV	DESCRIPTION	BY	DATE	DRAWING NAME	TITLE	THESE DRAWING


		_ /			
COPYRIGHT	SI	GNED APPROV	/AL		
THESE DESIGNS, PLANS AND INFORMATION ARE COPYRIGHT AND ARE	APPROVED	Mila	7MAY2022		
NOT TO BE USED OR REPRODUCED WHOLLY	RPEQ	6715			
OR IN PART OR TO BE USED ON ANY PROJECT	REVIEWED				
WITHOUT THE WRITTEN	DESIGNED	RAB	MAY 2022		
PERMISSION OF SUMMERMORE PTY LTD	DRAWN	GAB	MAY 2022		
DO NOT SCALE FROM	SCALE	AS SHOWN			
THESE DRAWINGS.	ORIGINAL DRAWING SIZE at A3				



FACTORY POOLS PERTH 21 Edison Circuit, Forrestdale, WA, 6112.

PROJECT	GENERIC STRUCTURAL DETAILS
TITLE	
	HAMPTON RANGE

10 WH 10 W 10 W	
DRAWING NUMBER	REV
16-11406-S04	С

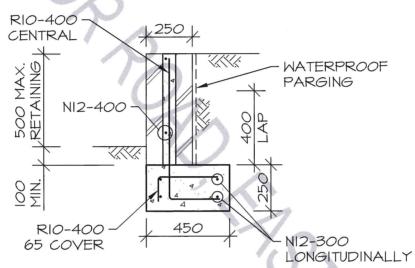

TYPICAL RETAINING WALL SECTION

SITE CLASSIFICATION


NI-WIND CLASSIFICATION IN ACCORDANCE WITH AS4055 WIND LOADS FOR HOUSING.

A-SOIL CLASSIFICATION IN ACCORDANCE WITH AS2870 RESIDENTIAL SLABS AND FOOTINGS.

NOTES:

- I. ALL MASONRY WORK SHALL BE IN ACCORDANCE WITH AS3700 'MASONRY STRUCTURES'.
- 2. ALL CONCRETE WORK SHALL BE IN ACCORDANCE WITH AS3600 'CONCRETE STRUCTURES'.
- 3. CONCRETE STRENGTH TO BE MIN. 20 MPa.
- 4. DO NOT SCALE FROM DRAWINGS.
- 5. ALL DIMENSIONS IN MILLIMETERS. U.N.O.
- 6. ALL MEASUREMENTS TO BE CHECKED ONSITE PRIOR TO CONSTRUCTION.

BY A	AN AUTH	ORISED CO	:VISION '0' OR LATER AND SIGNED MPANY REPRESENTATIVE THIS 3E USED FOR CONSTRUCTION HOUT WATERMARKED ADDRESS	SINISA VUKSA BEng MIEAust CPEng NER No.2463578		3	B WADDELL CONSULTING ENGINEERS	
				Date JUNE 2022	Project	44 WINDSOR ROAI PROPOSED RETAI	D, EAST FREMANTLE NING WALL	Job No: 30187
Α	TD	08/06/22	ISSUED FOR CONSTRUCTION	Scale AS SHOWN AT A3	Client	SPECIALISED BUIL	DING SOLUTIONS	Drg No: S1
REV	BY	DATE	REVISION DESCRIPTION	AS SHOWN AT AS				31

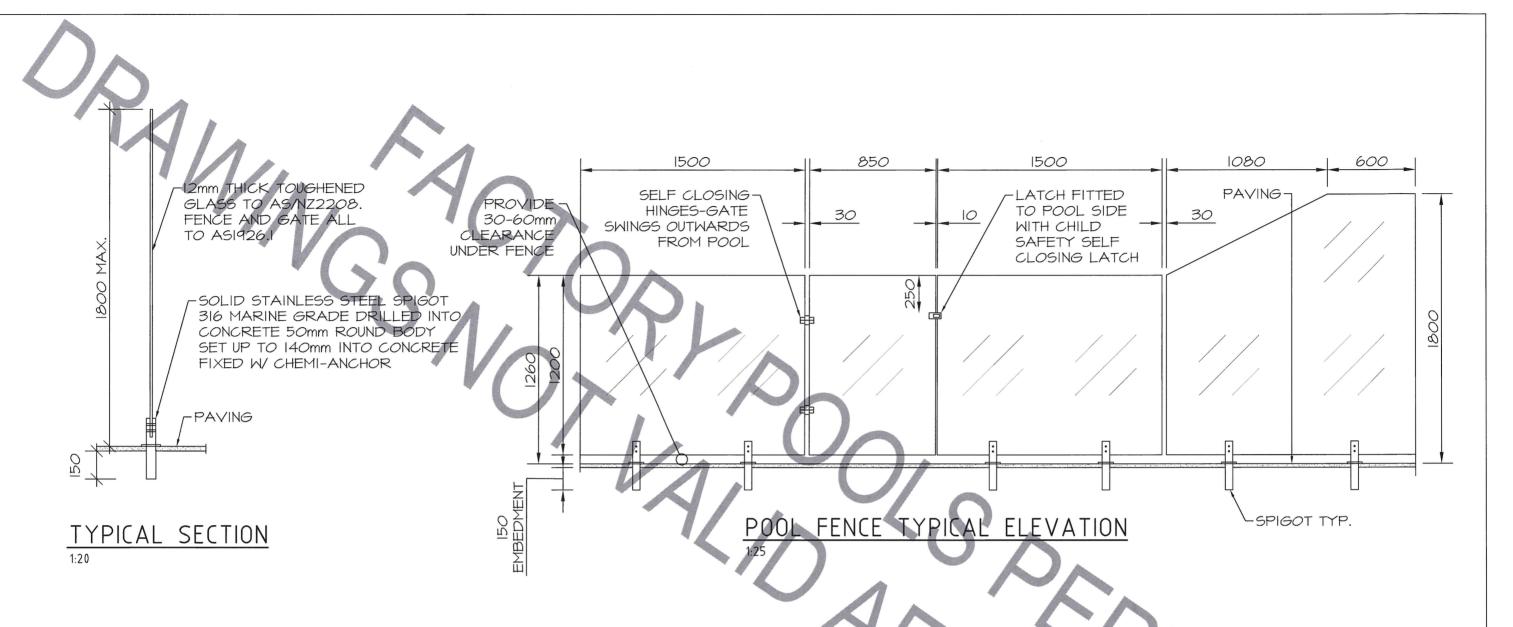

GENERAL NOTES

- I. AUTHORIZED REQUIREMENTS OF LOCAL AUTHORITIES AND OTHER STATUARY AUTHORITIES TO BE COMPLIED 2. CONCRETE
 - -TO BE IN ACCORDANCE WITH AS3600
 - -TO BE KEPT MOIST AND CURED FOR A MINIMUM OF 7 DAYS
 - -COMPRESSIVE CYLINDER STRENGTH AT 28 DAYS I'C = 20MPa
 - -FOR POURED LIMESTONE, MIN COMPRESSIVE STRENGTH = 12MPa
 - -MAXIMUM AGGREGATE SIZE = 20mm
- 3. BASE
- -MIN 600mm DEPTH TO BE COMPACTED, MIN. 5 BLOWS/300mm ON A STANDARD FALLING WEIGHT PENETROMETER 5. IF SITE CONDITIONS ARE SIGNIFICANTLY DIFFERENT FROM THOSE SHOWN, CONSULT THE ENGINEER

LINE FOR INDICATED BY DEVICION IOLOD LATED AND CICNED


- 6. SPIGOTS ARE TO BE SPACED AT THE FOLLOWING CENTERS:
 - -1200mm FOR 1200mm HIGH GLASS
 - -900mm FOR 1800mm HIGH GLASS


STRUCTURAL NOTES

DESIGN CRITERIA

- I. DESIGN WIND CLASSIFICATION TO ASIITO.2 R=1:100 REGION = AI TERRAIN CATEGORY = 2.5 SHIELDING MULTIPLIER = 0.9
- 2. DESIGN SOIL CLASSIFICATION A - SOIL CLASSIFICATION IN ACCORDANCE WITH AS2870 RESIDENTIAL SLABS AND FOOTINGS.

BY A	N AUTH	ORISED CO	MPANY REPRESENTATIVE THIS BE USED FOR CONSTRUCTION	MUNDLES			B WADDELL	2
DRA	WING NO	OT VALID WI	THOUT WATERMARKED EXPIRY	BRETT WADDELL BEng CWEng FIEAust CPEng NER No.465326 RPEQ	-		CONSULTING ENGINEERS	10
				Date	Project			Job No:
				JUNE 2021		GLASS POOL FI	ENCING - CLASS A SOIL	28058
Α	TD		BUILDING LICENCE ISSUE	Scale AS SHOWN AT A3	Client	FACTORY POOL	S DEDTH	Drg No:
REV	BY	DATE	REVISION DESCRIPTION	AS SHOWN AT AS		TACTON FOOL	LO F LIXIII	S1

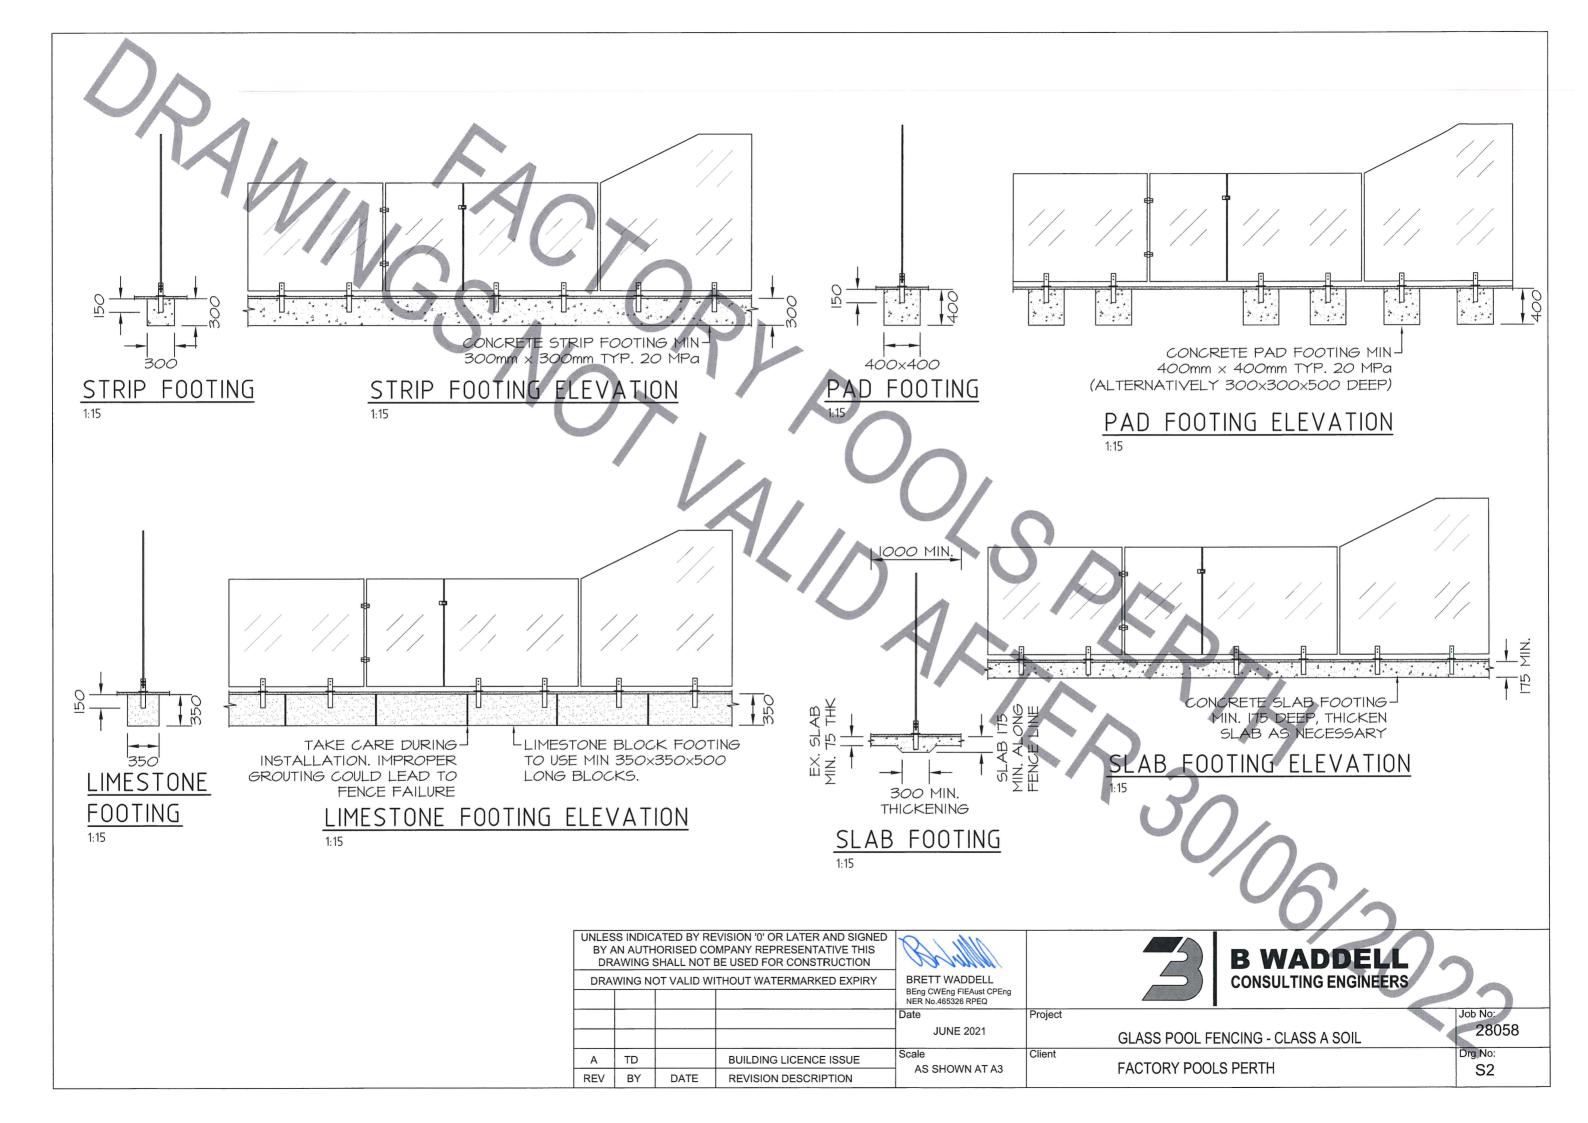

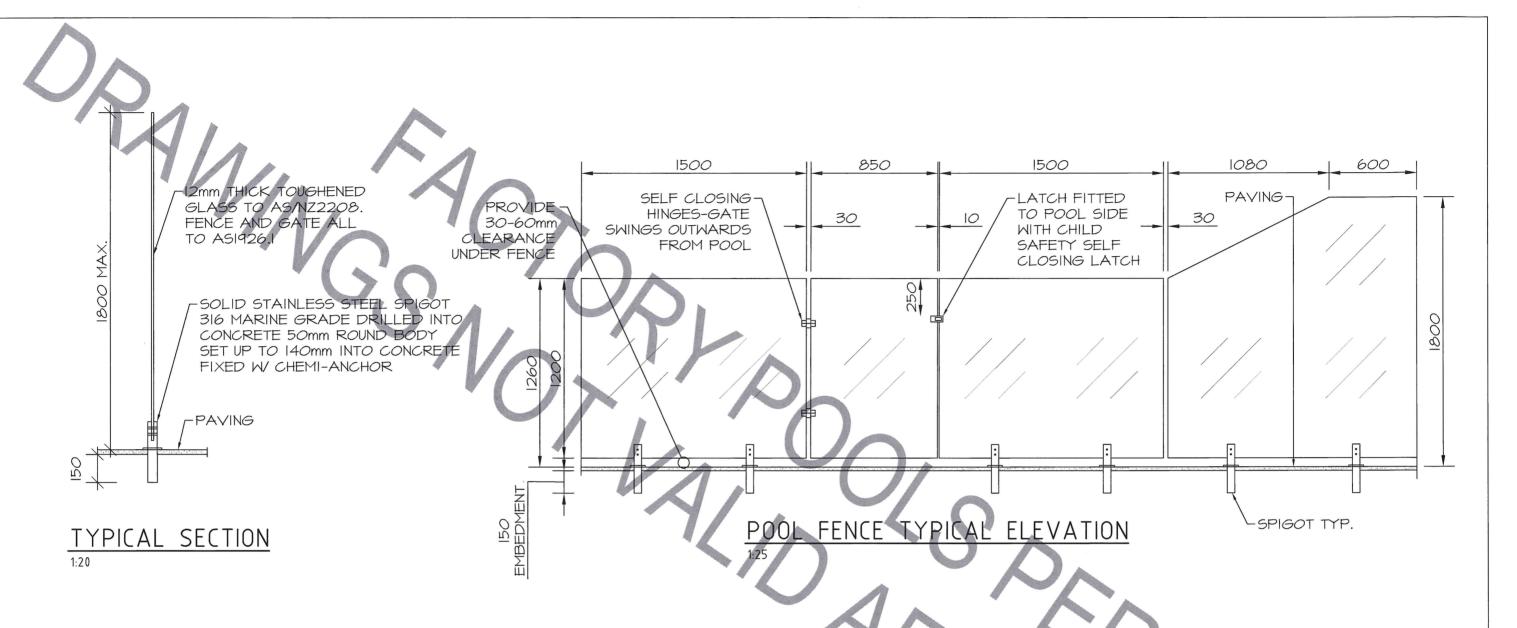

GENERAL NOTES


- I. AUTHORIZED REQUIREMENTS OF LOCAL AUTHORITIES AND OTHER STATUARY AUTHORITIES TO BE COMPLIED W 2. CONCRETE
 - -TO BE IN ACCORDANCE WITH AS3600
 - -TO BE KEPT MOIST AND CURED FOR A MINIMUM OF 7 DAYS
 - -COMPRESSIVE CYLINDER STRENGTH AT 28 DAYS f'c = 20MPa
 - -FOR POURED LIMESTONE, MIN COMPRESSIVE STRENGTH = 12MPa
 - -MAXIMUM AGGREGATE SIZE = 20mm
- 3. BASE
- -MIN 600mm DEPTH TO BE COMPACTED, MIN. 5 BLOWS/300mm ON A STANDARD FALLING WEIGHT PENETROMETER 5. IF SITE CONDITIONS ARE SIGNIFICANTLY DIFFERENT FROM THOSE SHOWN, CONSULT THE ENGINEER
- 6. SPIGOTS ARE TO BE SPACED AT THE FOLLOWING CENTERS:
 - -1200mm FOR 1200mm HIGH GLASS
 - -900mm FOR 1800mm HIGH GLASS


STRUCTURAL NOTES

DESIGN CRITERIA

- I. DESIGN WIND CLASSIFICATION TO ASIITO.2 R=1:100 REGION = AI TERRAIN CATEGORY = 2.5 SHIELDING MULTIPLIER = 0.9
- 2. DESIGN SOIL CLASSIFICATION S AND M - SOIL CLASSIFICATION IN ACCORDANCE WITH AS2870 RESIDENTIAL SLABS AND FOOTINGS.

Γ	IINI EQ	S INIDIO	ATED BY DE	VISION '0' OR LATER AND SIGNED					
	BY A	N AUTH	IORISED CO	MPANY REPRESENTATIVE THIS BE USED FOR CONSTRUCTION	MilwEll		45)	B WADDELL	$2 \sim$
	DRAV	WING N	OT VALID WI	THOUT WATERMARKED EXPIRY	BRETT WADDELL		(CONSULTING ENGINEERS	
					BEng CWEng FIEAust CPEng NER No.465326 RPEQ				
					Date	Project			Job No:
l					JUNE 2021		GLASS POOL FE	ENCING - CLASS S & M SOIL	28058
	Α	TD		BUILDING LICENCE ISSUE	Scale AS SHOWN AT A3	Client	FACTORY POOL	¢ DEDTH	Drg No:
	REV	BY	DATE	REVISION DESCRIPTION	AS SHOWN AT AS		PACTORT POOL	SPERIII	S1

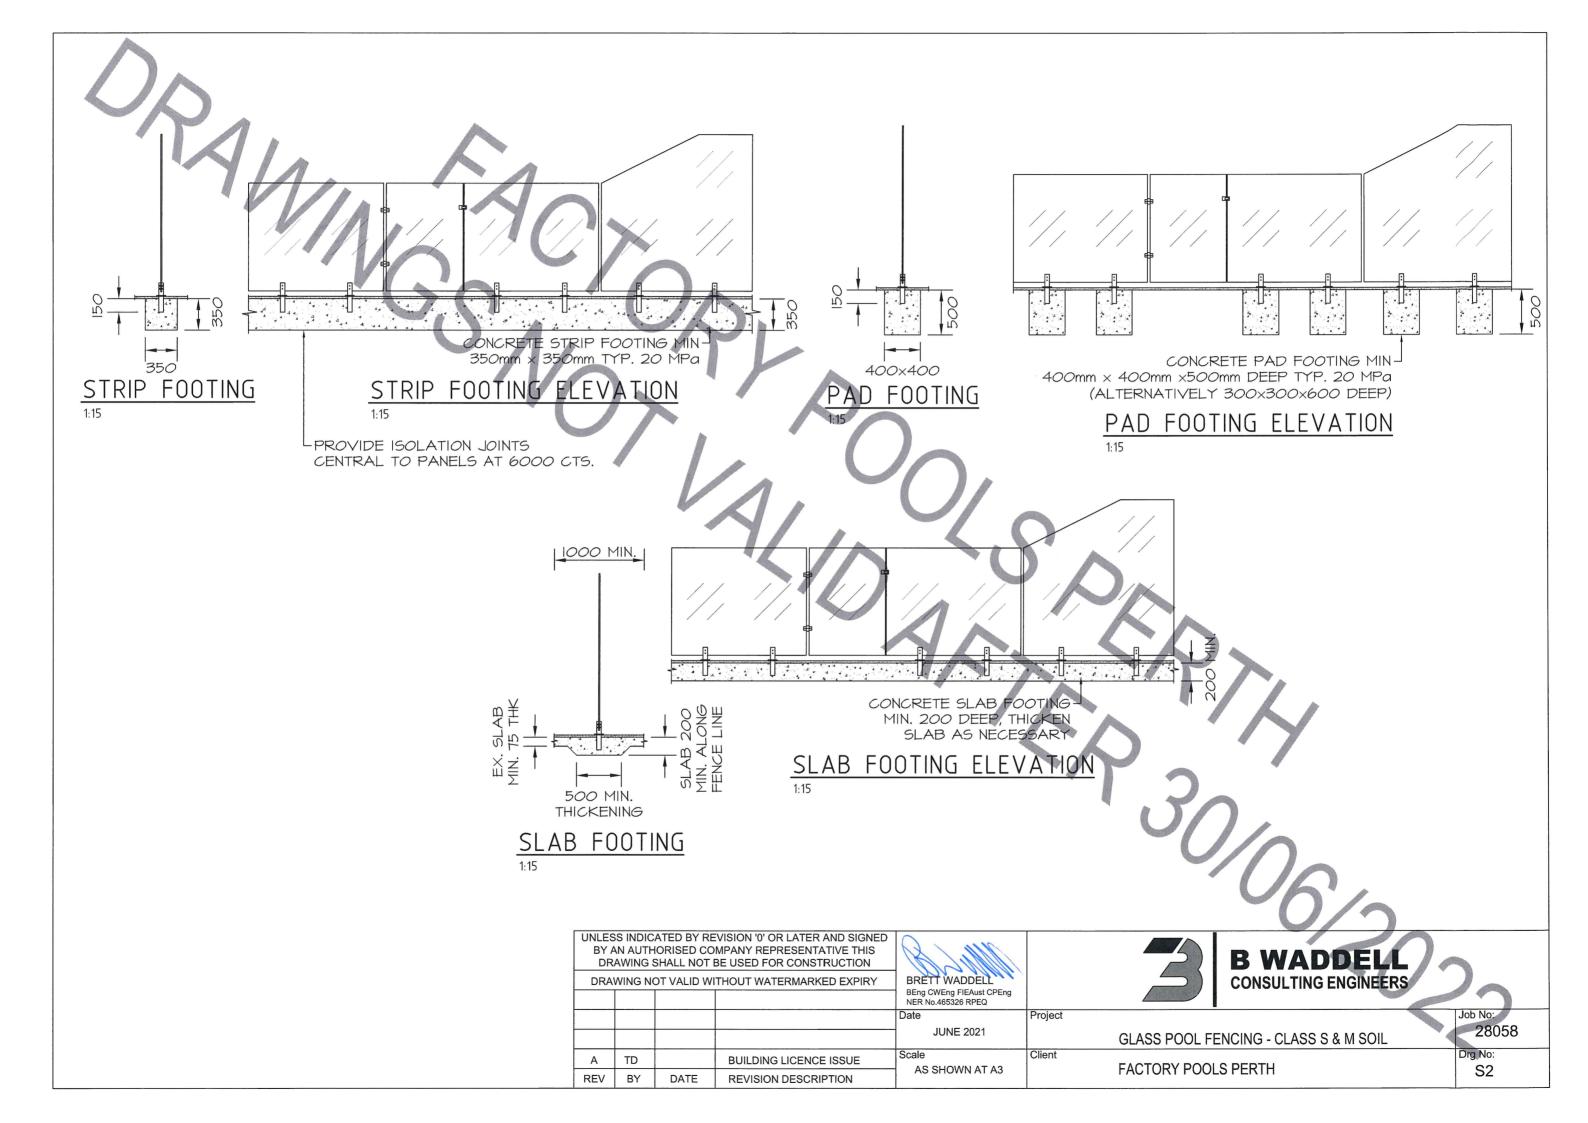

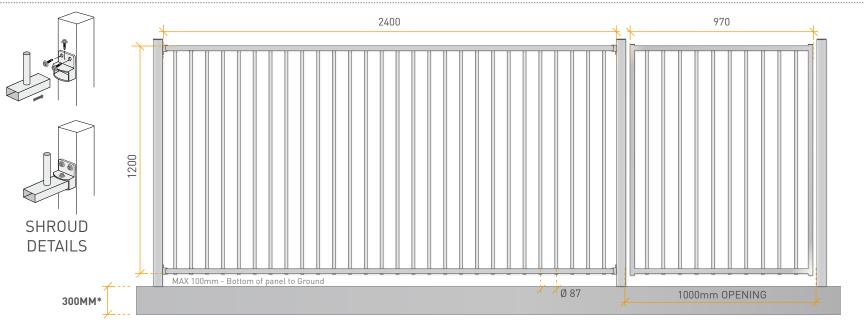


*RECOMMENDED CONCRETE FOOTING DIMENSIONS ONLY - Thickness of footing is dependent on local wind speed and soil type. Ensure you seek independent advice relating to appropriate footings before installing your posts.

600mm 500 ∠ 200mm → IN GROUND POST DETAIL

*RECOMMENDED FOOTING DIMENSIONS ONLY

HIGHER CUSTOM PANELS - Custom panels 1500mm High and above will have an extra rail 1200mm down from the top of the panel. If you require the extra rail

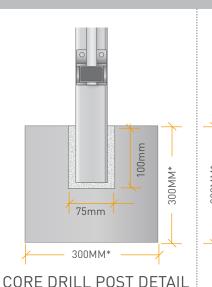

*RECOMMENDED FOOTING DIMENSIONS ONLY

WELDED **BASE PLATE** 100 x 100mm *MM001 300MM* 50 x 50 Ø 70 Ø 70

OXWORKS

STANDARDS

AS1926.1 (2012) Pool Safety Standards

PANELS - 6063 T6 Aluminium

2400/3000mm x 1200mm Panel - P/coated 38 x 25m x 1.6mm RHS 16mm CHS (1.2mm) Vertical Tubes

FIXINGS

38 x 25mm Horizontal Fence Brackets 2 Hole - Single Lugged

3 x 12-14*20 Self Tapping Tek Screws used per Fence Bracket

GATES - 6063 T6 Aluminium

970/1475mm x 1200mm Gate - P/coated 38 x 25mm Frame (Non-Mitred)

6063 T6 ALUMINIUM POSTS

50 x 1800 x 1.9mm In Ground Post 50 x 2100 x 1.9mm In Ground Latch Post 50 x 1300 x 1.9mm Flanged Post $50 \times 1600 \times 1.9 \text{mm}$ Flanged Latch Post

• In Ground Post 200 x 500/600mm Post Hole Hole filled with Post Mix Concrete

. Core Drilled Post

TOP RAIL(S)

2 WELDS

Minimum 75mm x 100mm Core Drill Hole filled with MP60 Non-Shrink Bostik Grout

- Flanged Post On Slab M10 x 75mm Glavanised Dyna Bolt
- Flanged Post On Timber 14 x 75mm Hex Head Batten Screw into Structural timber

RECOMMENDED LATCH & HINGE

FR5091 - D&D Tech Top Pull Magna Latch NATA Test Report #2013-026-S1L

HW2010 - D&D Tech Kwik Fit Spring Hinges HW2020 - D&D Tech Std TruClose Hinges

NATA Test Report #2014-027-S2H

NB: Oxworks' Hinges & Latches installed correctly comply with clause 2.4.3 of AS1926.1 - 2012

NB: All measurements have a manufacturing tolerance of +/- 2mm

TITLE: ALUMINIUM POOL FENCING FLAT TOP

oxworks.com.au 1300 336 237



