

BUILDING NOTES

1.1 General:

All work will be done in accordance with The National Building Code (NBC), relevant Australian Standards (AS). Local Council By-Laws and as per good trade practice

DO NOT SCALE OFF DRAWINGS - When in doubt refer to the Dimensions shown on plans may be amended to facilitate construction. Any change over 50mm to be referred to Designer Ensure that relevant larger section details are considered prior to attempting construction as these details may resolve some minor differences on plans

All proprietary products are to be installed as per Manufacturer's Recommendations (MR)

The Contractor is to ensure all underground investigation is

completed prior to starting construction

7. The Contractor is responsible for building set out

1.2 <u>Demolition</u>:

1. 2.1 Master Bedroom Renovations - Stage 1

- Roof Sheet, Gutters, Downpipes, etc. will be carefully removed and stored on site for possible later re-use if required
- All framing materials , roof, floor & ceilings will be carefully removed, de-nailed and stored on site for later possible re-use
- Where noted doors removed will be stored on site to prevent damage and distortion for possible later re-use
- 4. Pressed Metal door frames will not be re-used, Remove from site and dump. Aluminum Frames, doors & windows will be carefully removed and stored on site - for possible later re-use.
- Floor coverings (Carpet) will be pulled up and removed from site
- Brickwork & debris will be removed from site.
- 8. Existing timber handrail on front Balcony will be carefully removed.
- de-nalled and stored on site for possible later re-

1. 2.2 Extensions & Alterations over Bedroom 2 & 3 - Stage 2 Ground floor plasterboard ceilings will be supported during works

- to ensure their integrity. Any damage to lower floor plasterboard ceilings / walls will be made good :

 a. replaced where damage is too great
 b. patched where possible and
 c. repainted to match adjacent areas prior to completion of

 - the works
- 2. As per Items 1 8 in section 1.2.1 where applicable

1.3 BUILDING WORKS:

1. 3.1 Floor Framing

- 1. Floor framing will be Hyne "I" beam style or equivalent, sized and spaced as per the Structural Engineer's specifications
- 2. Spans over 3000mm will be herringbone braced
- 3. Wet Areas will be set down 30mm to allow membrane and sub-floor grading for falls
- Floor framing will be appropriately fixed to lower floor structure as per NBC

1. 3.2 Flooring

- 1. Flooring will be yellow tongue, water resistant sheet flooring 19mm thick, glued and nailed to floor joists
 - Wet Area Floors are to clad over sheet flooring with Fibre Cement sheeting Wet Area floors are to be fitted with waterproof

 - polyurethane membrane to prevent water egress Wet Area Membrane is to be taken a minimum of 200mm up all walls with reinforced corners
- 2. Sheet flooring is to be protected to minimize water egress during
- Prior to laying floor sheeting, the floor / ceiling space is to be fitted with Rock-wool acoustic bats cut and fitted neatly between

1. 3.3 Wall Framing

- 1. All studs & plates will be M12 treated pine 90 x 45mm
- 2. Stud spacing will be @ 400mm centres
- 3. All walls will have a noggin row at midpoint floor to ceiling

framing. No air gaps allowed.

- 4. 170 x 45mm treated pine will be used as noggins and placed at midpoint for all wall mounted fixtures and fitting at the height denoted on plans
- Window & door head sizing will be as per the Engineer's specifications / NBC
- 6. Walls will be braced with either hoop iron strap bracing or sheet bracing as denoted on Engineering Drawings as per NBC

1. 3.4 External Cladding

- 1. All new upper floor walls will be fitted with appropriate vapour barrier over framing
- 2. All upper floor cladding will be 7.5mm Hardies Blue Board as pe
- The Fibre Cement Cladding will receive Granosite type Acrylic Render (colour to be selected)
- 4. The bottom edge of F/C cladding will be fitted with Hardies 9mm Aluminum Horizontal Step Flashing with rounded bottom scroll in selected powder-coated colour.
- 5. The existing brickwork above the trim line (this line will be taken around the dwelling at a consistent level) of the new cladding will be coated with the same coloured and finish acrylic render as with the F/C sheeting
- 6. Soffit width is to be consistent with the existing dwelling (approx.
- 7 Soffit sheeting will be 4.5mm F/C sheeting
- All new external walls will be fitted with R2.5 thermal bats neatly cut and fitted between framing

1. 3.5 Roof Framing

- 1. Where possible, re-use existing saved roof framing
- 2. All new timbers will be at a minimum grade of M12
- 3. Roof framing will be fixed to with appropriate trip-l-grips and strapping as per NBC

1. 3.6 Roof Cladding

- 1. Where possible, re-use existing saved roof sheeting. New sheetinbg will match existing.
- 2. Roof framing will be fitted with R1.5 "Anticon" immediately under
- Skylight is to fitted & ducted through roof sheet over the new WC. It will be also be fitted with automatic Exhaust system. Ducted exhaust fan is to be fitted in new bathrooms vented through roof cladding

1. 3.7 <u>Doors</u>

- 1. Re-use existing, recovered doors where possible
- 2. All internal doors will be flush panel, hollow core 35mm thick 3. All locks will be matched to and at similar heights to existing

1. 3.8 Door Frames

1 No old door frames are to be re-used

 All door frames will be pressed metal to designated sizes or to accommodate re-used doors and as per Schedule supplied

1. 3.9 Internal Cladding

- All internal walls will be clad with 10mm plasterboard glued and screwed to framing
- All Wet Areas will be clad with water resistant plasterboard (MR) The bottom edge of all sheeting is to be kept clear of floor (as per MR) and only square edge - no recessed edge to bottom of
- All upper ceilings will be fitted with R3.5 thermal bats cut and fitted neatly between framing.
- 5. Cornice will be 75mm plaster cove.
- External corners / reveals will be reinforced with perforated metal corners with angles set as close to square as possible
- 7. Where plasterboard abuts aluminum frames the sheeting will be fitted with PVC casing bead or
 - the process square edge of sheeting will be used
- Wall sheeting will penetrate back throat of pressed metal door frame to ensure solid fitting frames
- Any mindr fluctuations in framing will be addressed by cladding tradesmen to minimize deflection in sheeting 10. Proprietary Roof Access Ladder will be fitted as denoted on plans
- approx. opening 57 x 137mm
- Ceiling space around / adjacent to Roof Access Ladder will be fitted with 17mm Structural ply fixed to the top of ceiling joists to achieve a general area of 10m² storage space

1. 3.9 Finishes

1.3.10.1 Ceramic Tiling


- 1. Bathroom will have Ceramic tiles (to be selected by Owner) on all walls to height of window head.
- External corners of tiling at reveals and elsewhere will be formed using proprietary powder coated aluminum angles to match tile
- 3. Floor tiles will have falls to floor wastes and will not allow ponding 4. Tile junction Wall / floor and internal vertical corners will be neatly
- aled with appropriate colour sealant 5. Taps & Hardware are to be sealed to adjacent tiles to prevent
- water leakage. 6. Floor wastes are to be sealed to tiles with appropriate coloured
- sealant as per wall floor junction

1.3.10.2 Painting

- 1. All new surfaces which are to be painted will be cleaned down to remove all dirt, dust and loose particles prior to applying sealers / undercoats.
- 2. Appropriate primer / sealer/ undercoat is to be applied to all new
- 3. Ceilings are to be painted with a minimum of 2 x finish coats of "Ceiling White" water based paint
- Walls are to be painted with a minimum of 2 x finish coats of water based "wash & wear" paint to the selected colour.
- Doors & Frames are to be painted with a minimum of x coats of Full Gloss enamel paint to match wall colour
- Painter is to ensure full coverage with no under colour showing through new work. Additional coats to be applied if necessary


1.3.11 Windows & Glazing

- Western & Eastern facing windows are to be glazed with Comfort Plus glass
- 2. Window framing is to match existing dwelling windows as near as
- New Bathroom windows are to match lower floor obscure style of

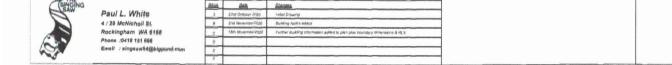


Lacey & Adam Filipich 2 Easton Street East Fremantle



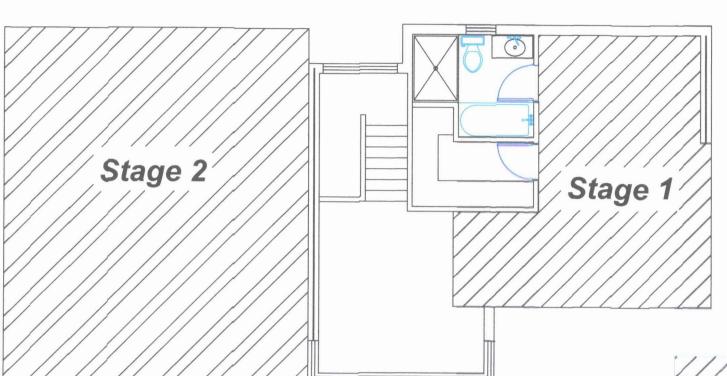

TOWN OF EAST FREMANTLE
PLANNING APPLICATION
DATE NO 13 9 - 2 0

RECEIVED

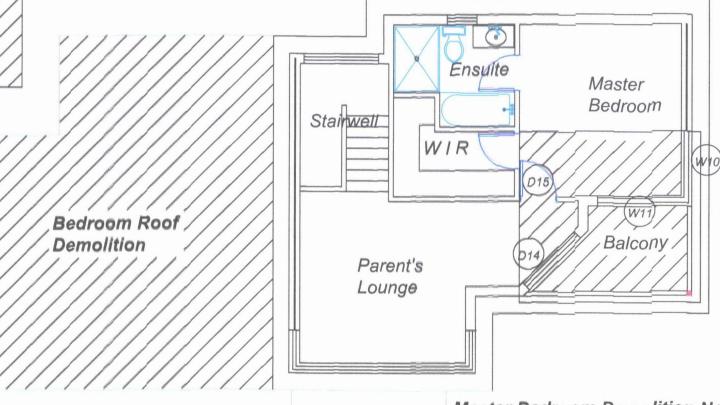

Bedroom Roof Demolition Notes

- 1. Total removal of roof sheet, gutters and metal fascias over Bedroom 2 & 3
- 2. Remove Roof framing de-nail and store on site
- 3. Structural Ply Sheet under all ceilings and install stable supports
- Remove hanging beams supporting Ceiling Joists
- 5. Concrete Saw cut new doorway through from Parent's Lounge


Master Bedroom Demolition Notes

- 1. Partial removal of roof over W11
- 2. Install new Hanging Beam over wall line
- B. Demolish brick wall, W11 and D 15
- 4. Demolish Brick wall containing D14
- 5. Demolish ceiling to Balcony & partially to M / Bedroom
- 6. Remove W10 and brick wall under
- 7. Demolish Handrail to both sides of Balcony

THE	DESIGN	CUR
(SINGING		Ingu
LISAW	Paul L. White	A
	4 / 29 McNicholl St.	В
	Rockingham W4 6168	C
6	Phone :0418 151 866	D
	Email : singsaw94@bigpond.com	E

CURRE	WCY		
Issue	Date	Changes	
A	23rd October 2020	Initial Drawing	
В	3rd Navember 2020	Stage 3 added	
С	15th November 2020	Stage 3 deleted, Demolition plan and Notes added	
D			
E			
F			

Lacey & Adam Filipich 2 Easton Street East Fremantle PROPOSED ALTERATIONS
2 Easton Street
East Fremantle

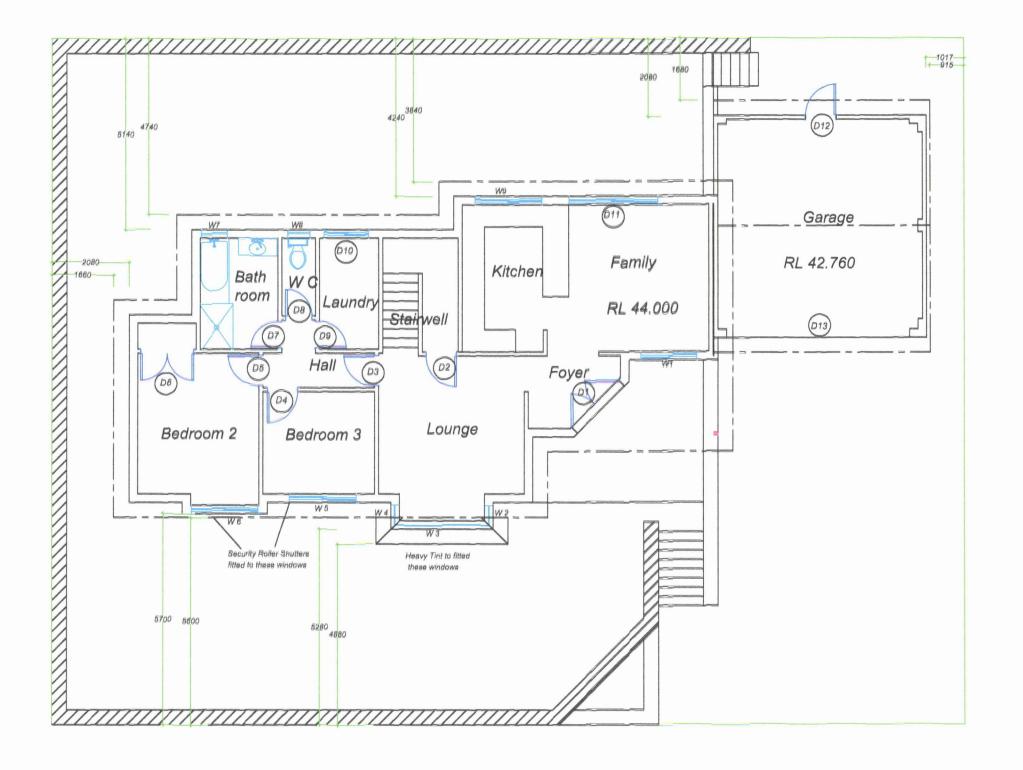

TOWN OF EAST FREMANTLE PLANNING APPLICATION

2 5 NOV 2020 P 1 3 9 - 2 0

RECEIVED


WINDOW SCHEDULE

No.	Location	Height	Width	Config.	
Groun	d Floor				
W1	Family Room	2110	1510	OX	
W2	Lounge	1210	610	Fixed	
W3	Lounge	1210	2550	OXXO	
W4	Lounge	1210	610	Fixed	
W5	Bedroom 3	1210	1510	OX	
W6	Bedroom 4	1210	1510	OX	
W7	Bathroom	1210	910	Vented	
W8	Toilet	910	610	Vented	
W9 Kitchen		910	10 1510 OX		
Upper	Floor				
W10	Master Bedroom	1210	1510	OX	
W11	Master Bedroom	1210	1510	OX	
W12	Parent's Lounge	1210	910	Fixed	
W13	Parent's Lounge	1210	4150	OXXO	
W14	Parent's Lounge	1210	910	Fixed	
W15	Stairwell	1210	1210	OX	
W16	Master Bedroom	910	610	Vented	

THE	ESIGN	GUBBE	YGY			
SINGING		haup	Date	Ghanges		
Harm	Paul L. White	A	23rd October 2029	(rulial Brawing		
	4 / 29 McNichoil St.	B	9th November \$630	Brewing whole reduced to AROW Roundary classrances		
	Rockingham WA 6168	Rockingham WA 6168	Rockingham WA 6168	6	11th Movember 2929	Whatev numbering & eiting sidded, notes added, Door Numbering added
6.50	Phone :0418 151 666	0				
	Email : singsaw94@bigpond.com	E				
1 00		F.				

Lacey & Adam Filipich 2 Easton Street East Fremantle

Drawn By	Drawing Scale	Drawing Date
PLW	1:100	11th November 2020

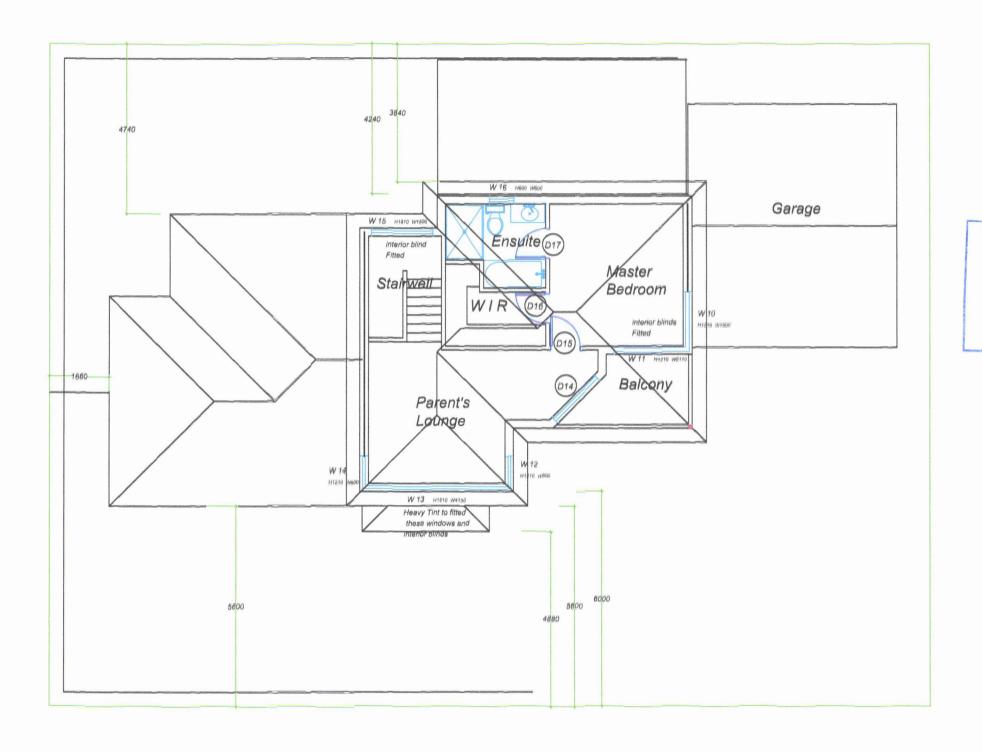

TOWN OF EAST FREMANTLE PLANNING APPLICATION

2 3 NOV 2020 P 1 3 9 - 2 0

RECEIVED

	_
BINGING	

Paul L. White 4/29 McNicholl St. Rockingham WA 6168 Phone: 0418 151 666 Email::singsaw94@bigpo


Lacey & Adam Filipich
2 Easton Street
East Fremantle

Drawn By.	ING UPPER F	Drawing Date
PLW	1:100	15th November 2020







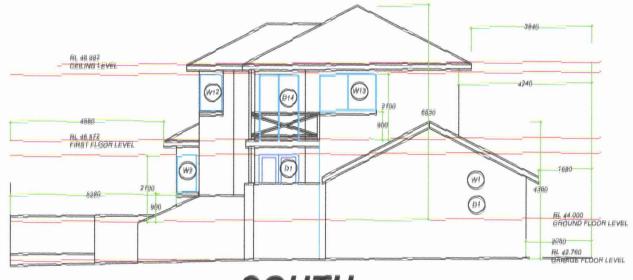

SOUTH


TOWN OF EAST FREMANTLE
PLANNING APPLICATION
DATE
PLANNING APPLICATION
100 P 139-20
RECEIVED

Contract of the second	NEING
-	
200	1
	3

Beslan	Che	nges to Brawings	A CONTRACTOR OF THE PARTY OF TH	
	ALC:US	Bass.	Explanation of Ehenges	
Paul L. White	A	73H (beledge 2020)	hikal Brawng	
4 / 29 McNicholl St.	it .	##4 7#Husmas 2629	Dimensione advised, hourseless distance and helights	
Reckingham WA 6168	ê	1 th Nevenher 2620	Whiteless & Block roumbering & Dimensioning added	
Phone :0418 151 866	0			
Email: singssw94@bigpond.com	E			
	P.			-


Lacey & Adam Filipich 2 Easton Street East Fremantie

Down By	Drawing Scale	Drawing Date	
PLW	NOT TO SCALE	11th November 2020	

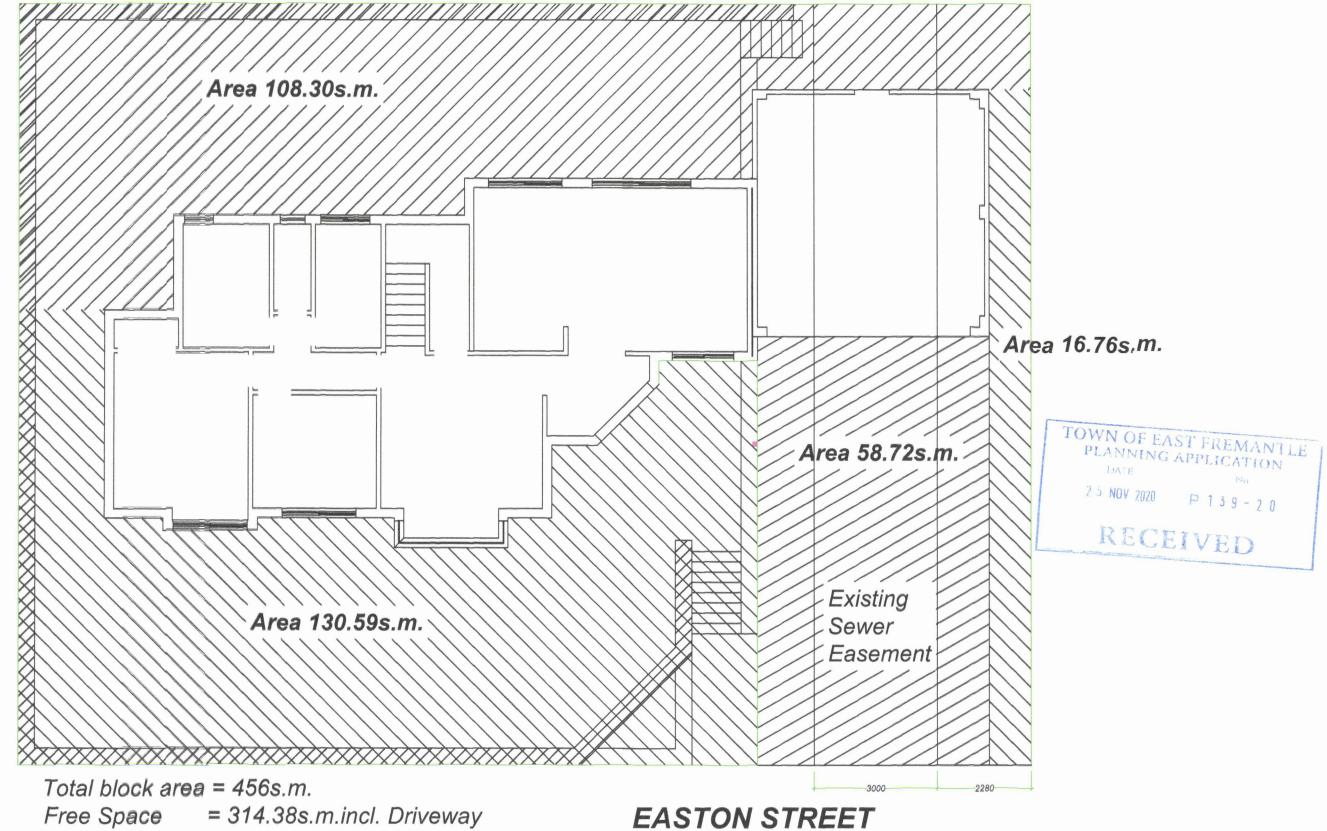

% Free Space = 68.94% incl. Driveway

(BINGING	DESKON	CURRENCY Date	Bhange	SLIMI. PROJECT	Drawing Title	REE SPACE AN	ALYSIS
Boun	Paul L. White 4/29 McNicholl St.	A 23rd October 2026j	Initial Statisting	Lacey & Adam Filipich PROPOSED ALTERATION	DNS Drawn By	Drawing Scale	Drawing Date
	Rockingham WA 6168	С		2 Easton Street 2 Easton Street	PŁW	NOT TO SCALE	23rd October 2020
	Phone :0418 151 666 Email : singsaw94@blgpond.com	E		East Fremantle East Fremantle	Drawing Number	708 . 01 -	05 A
		F				700.01	007

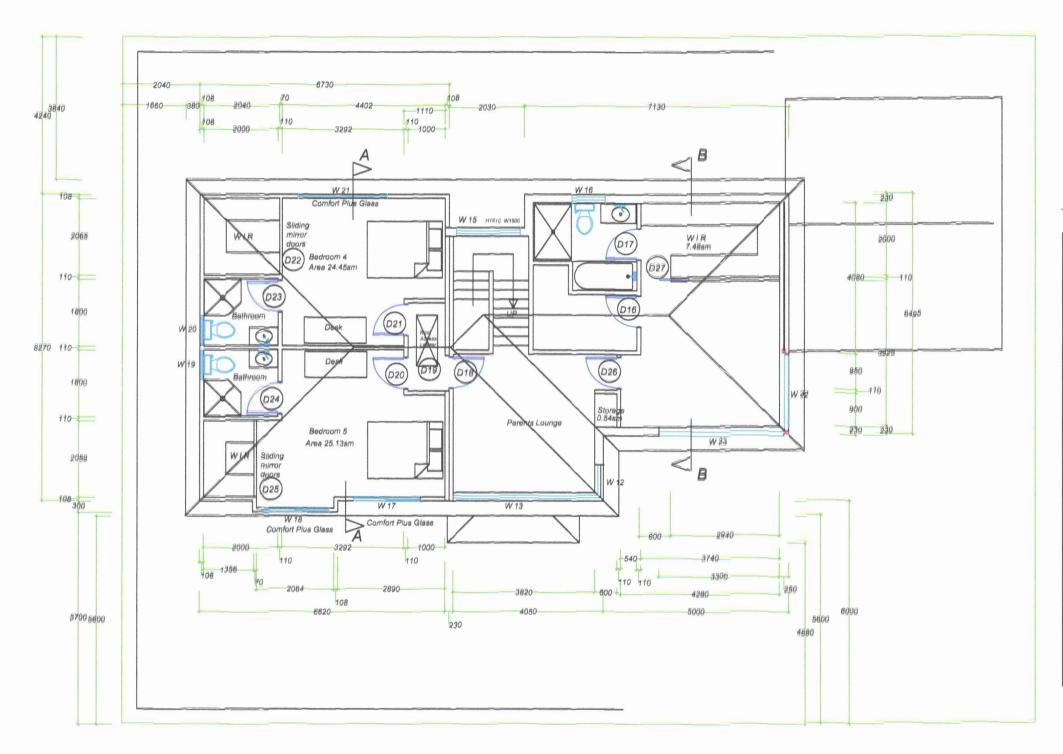




WINDOW SCHEDULE


No.	Location	Height	Width	Config.			
Grou	nd Floor						
W1	Family Room	2110	1510	OX			
W2	Lounge	1210	610	Fixed			
W3	Lounge	1210	2550	OXXO			
W4	Lounge	1210	610	Fixed			
W5	Bedroom 3	1210	1510	OX			
W6	Bedroom 4	1210	1510	OX			
W7	Bathroom	1210	910	Vented			
W8	Toilet	910	610	Vented			
W9	Kitchen	910	1510	OX			
Upper Floor							
W10	Master Bedroom	1210	1510	OX			
W11	Master Bedroom	1210	1510	OX			
W12	Parent's Lounge	1210	910	Fixed			
W13	Parent's Lounge	1210	4150	OXXO			
W14	DELETED						
W15	Stairwell	1210	1210	OX			
W16	Master Bedroom	910	610	Vented			
W17	Bedroom 5	1210_	1510	OX			
W18	Bedroom 5	1210	1510	OX			
W19	Bathroom	610	910	Vented			
W20	Bathroom	610	910	Vented			
W21	Bedroom 4	1810	2410	OXXO			
W22	Master Bedroom	1210	2000	OX			
W23	Master Bedroom	1210	3300	OXXO			

SINGING		JERUS	Date	Cheness
Havin	Paul L. White	A	23rd Ocluber 2080	Initial Drawing
	4 / 29 McNicholl St.	B	3rd November 2020	Alternative layout over Bed 2 & 3 adopted
	Rockingham WA 6168	0	9th November 2020	Alternative layout over Bed 2 & 3 adopted. WIR walls changed to mirror doors.
2.3	Phone :0418 151 666	D	10th November 2020	Dimensioning added.
	Email: singeaw94@bigpond.com	E	11th November 2020	Window information added, Door numbering added
4		F	15th November 2020	Window Schedule added, Drawing brought to Scale


Lacey & Adam Filipich 2 Easton Street East Fremantle

Drawn 8y	Drawing Scale	Drawing Date
PLW	1:100	15th November 202

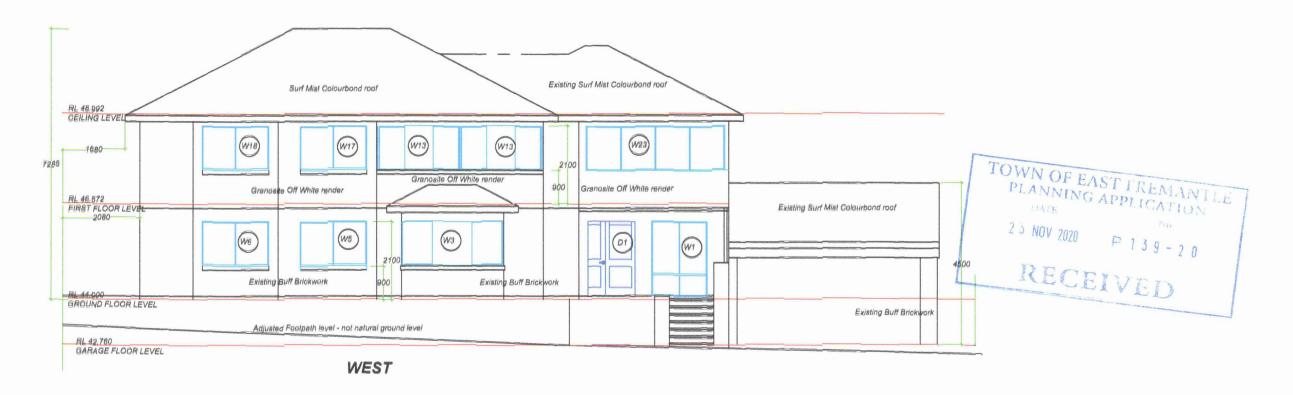


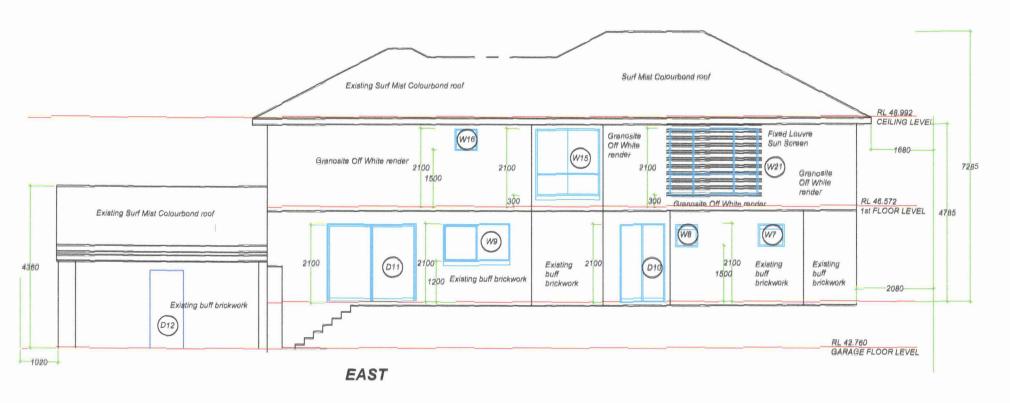


SINGING	DESIGN	CURRENCY Issue	Date	Chances	GLEST, END. SET.	PROPOS	SED EAST & WES	ST ELEVATION
Azam	Paul L. White	A 2	and October 2020	Initial Drawing	Lacey & Adam Filipich PROPOSED ALTERATIONS	P ₁₁	Desiring Scale	I Describe Date
	4 / 29 McNicholl St.	В 3	d November 2020	Alternative Myout over Bed if & miniples, ecrylic render is liquid figure		Drawn BY	Drawing Scan	Drawing Date
	Rockingham WA 6168	C 9	h November 2020	Alternative layout over Bed if & 3 exhipted, weight revides to eight 6565, heaching removed	2 Easton Street 2 Easton Street	PLW	1:100	15th November 2020
	Phone :0418 151 666	D t	th November 2020	Window numbering, dimension and idear rike address		Drawing Number		
2	Emall : singsaw94@bigpond.com	E 18	th November 2020	East & West Elevations brought to game plan, Drawing brought to sold: 1 : 100	East Fremantle East Fremantle		708 . 01 -	07 E

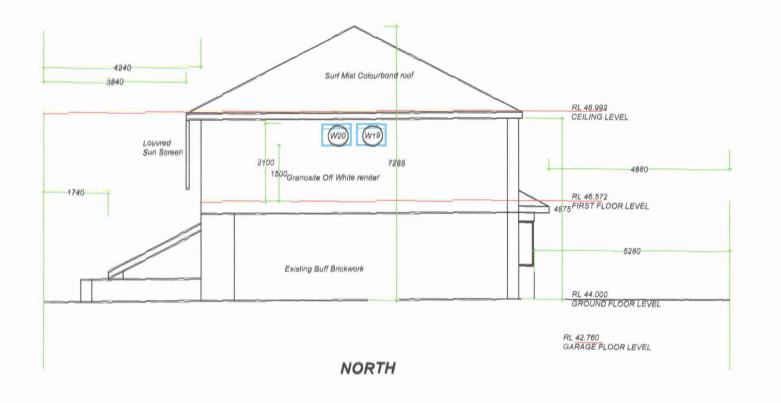



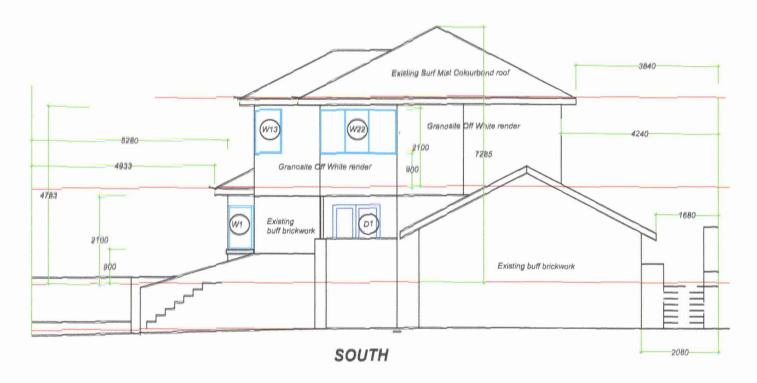

THE	DESIGN	CURREN	<u>er</u>		SLIGHT FED_HECT	Drawing Title	OSED NORTH & SOU	ITH FI
SAW	Paul L. White	A	23rd October 2020	Initial Drawing	Lacey & Adam Filipich PROPOSED ALTERATION		Drawing Scale	Drawio
	4 / 29 McNicholl St.	8	3rd November 2020	Alternative layout over Bed 2 & 3 adopted, acrylic render to top floor	2 Easton Street 2 Easton Street	PLW	1:100	
	Rockingham WA 6168 Phone :0418 151 666	С	9th November 2020	Afternative layout over Bed 2 & 3 adopted, acrylic render to top floor, hatching removed - dimensions added		Drawing Number		
	Email : singsaw94@bigpond.com	D	12th November 2020	Window & Door numbering and dimensioning added	East Fremantle East Fremantle		708 . 01 -	08
5		E	15th November 2020	North & South Elevations brought to one Drawing, Drawing brought to scale 1: 100				

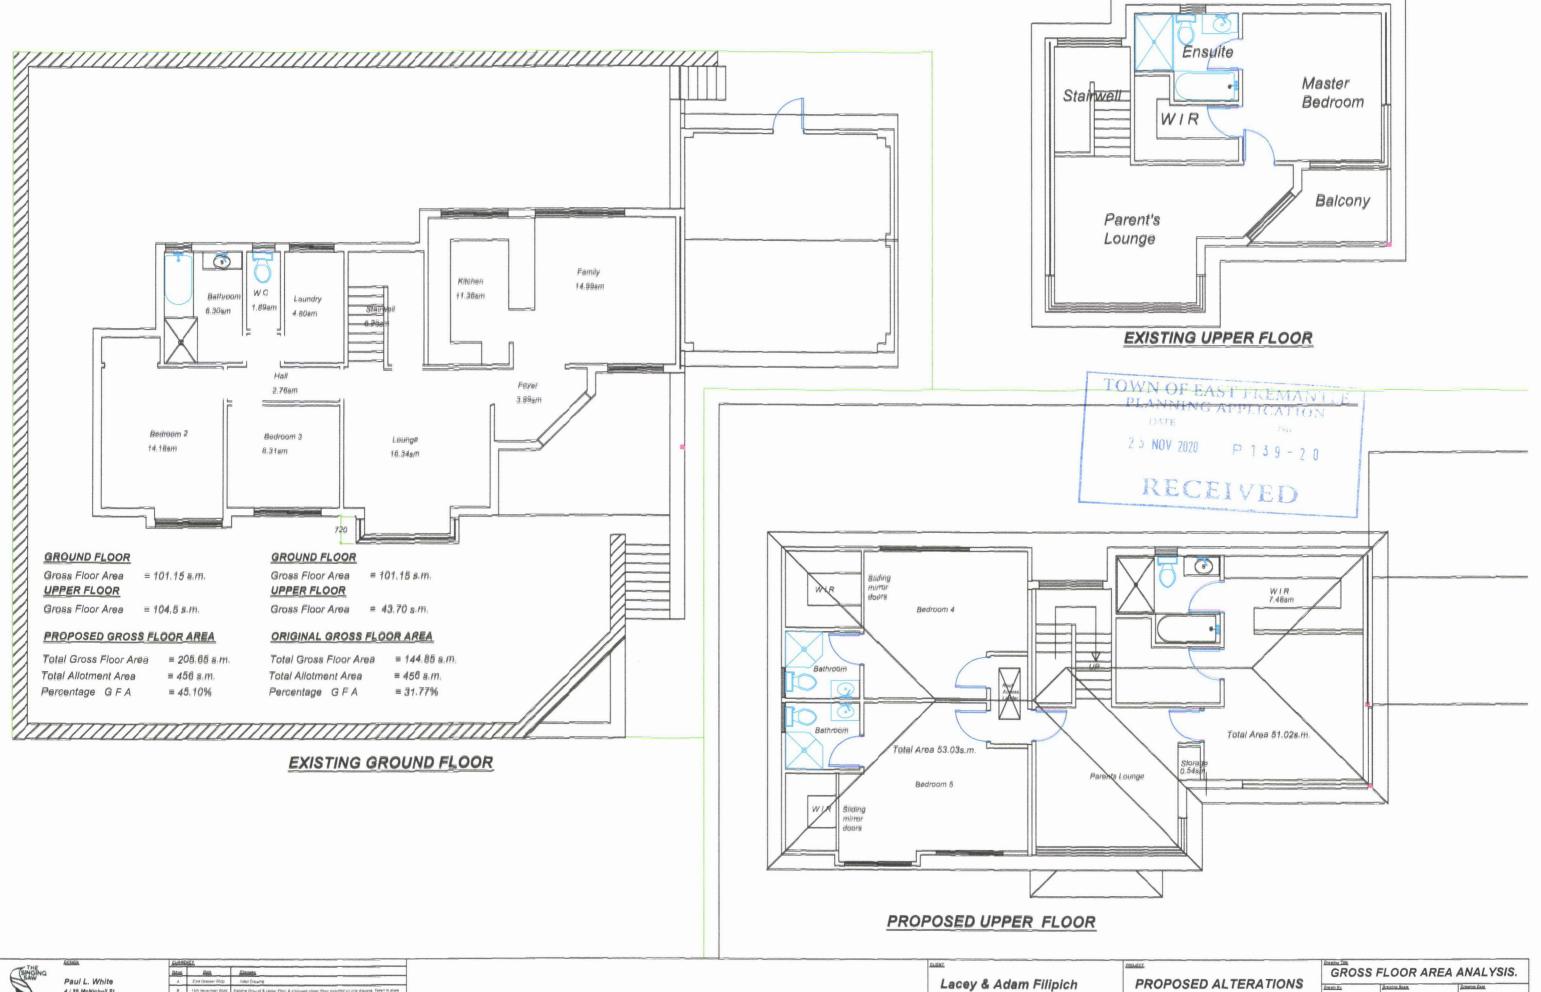

4 / 29 McNicholl St. Rockingham WA 6168 Phone: :0418 151 666 Email::singsaw94@bigpond.com A Eart Ordiner 2000 Intel Orauma


5 15th Resumber 2004 Paraling Oracurd & Litigar Florir & projected Lityer Flour resumed on one straining Team to area

C


D

E

Lacey & Adam Filipich 2 Easton Street East Fremantle PROPOSED ALTERATIONS
2 Easton Street
East Fremantle

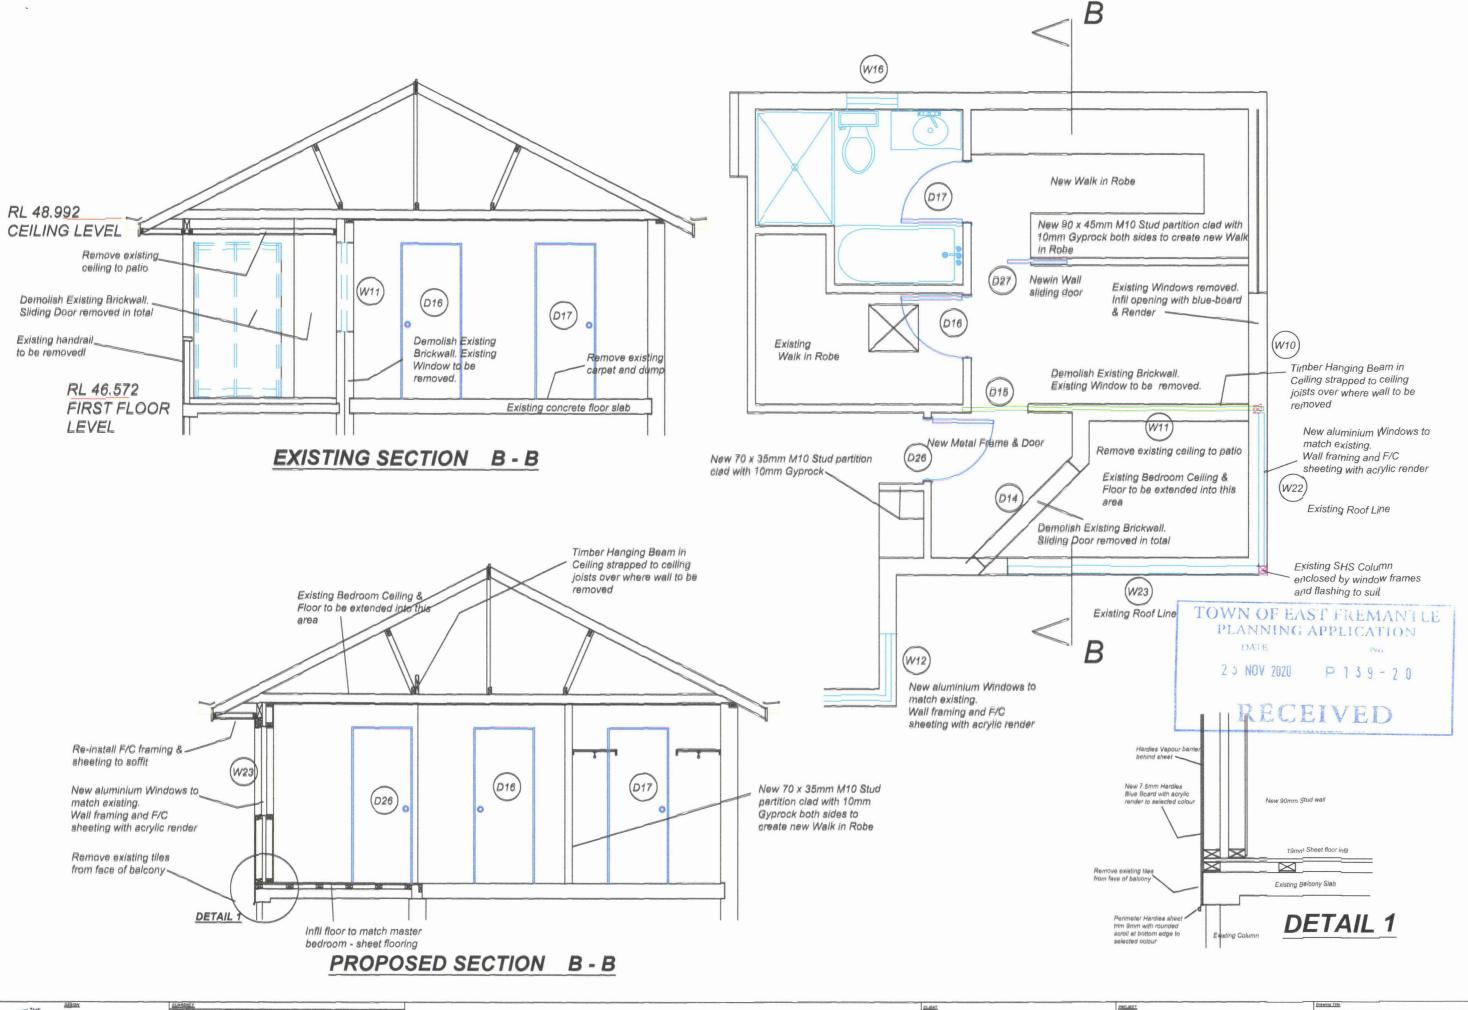

PROPOSED ALTERATIONS
Paul L. White
A 28th Chieffich ISt.
PROPOSED ALTERATIONS
A 20th Chieffich ISt.
PROPOSED ALTERATIONS
B 30th November 2020
B 30th November 2020
B 1 50th November 2020
B 25th Novem

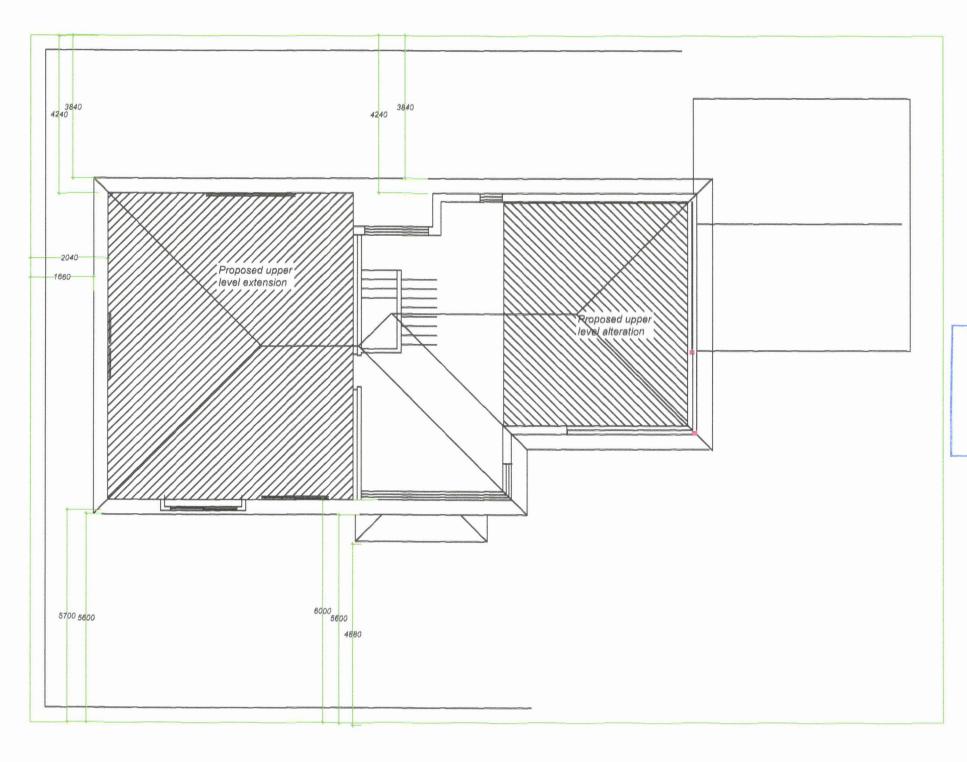

TOWN OF EAST FREMANTLE PLANNING APPLICATION

2 5 NOV 2020 P 1 3 9 - 2 0


RECEIVED

SINGING	
	i:
0	
100	

Paul L. White 4/29 McNicholl St. Rockingham WA 6168 Phone: :0418.151.686 Email::singsaw94@blgp.

Lacey & Adam Filipich 2 Easton Street East Fremantle

PRO	POSED WORK	AREAS
Drawn By	Drawing Scale	Drawing Date
PLW	1:100	15th November 2020

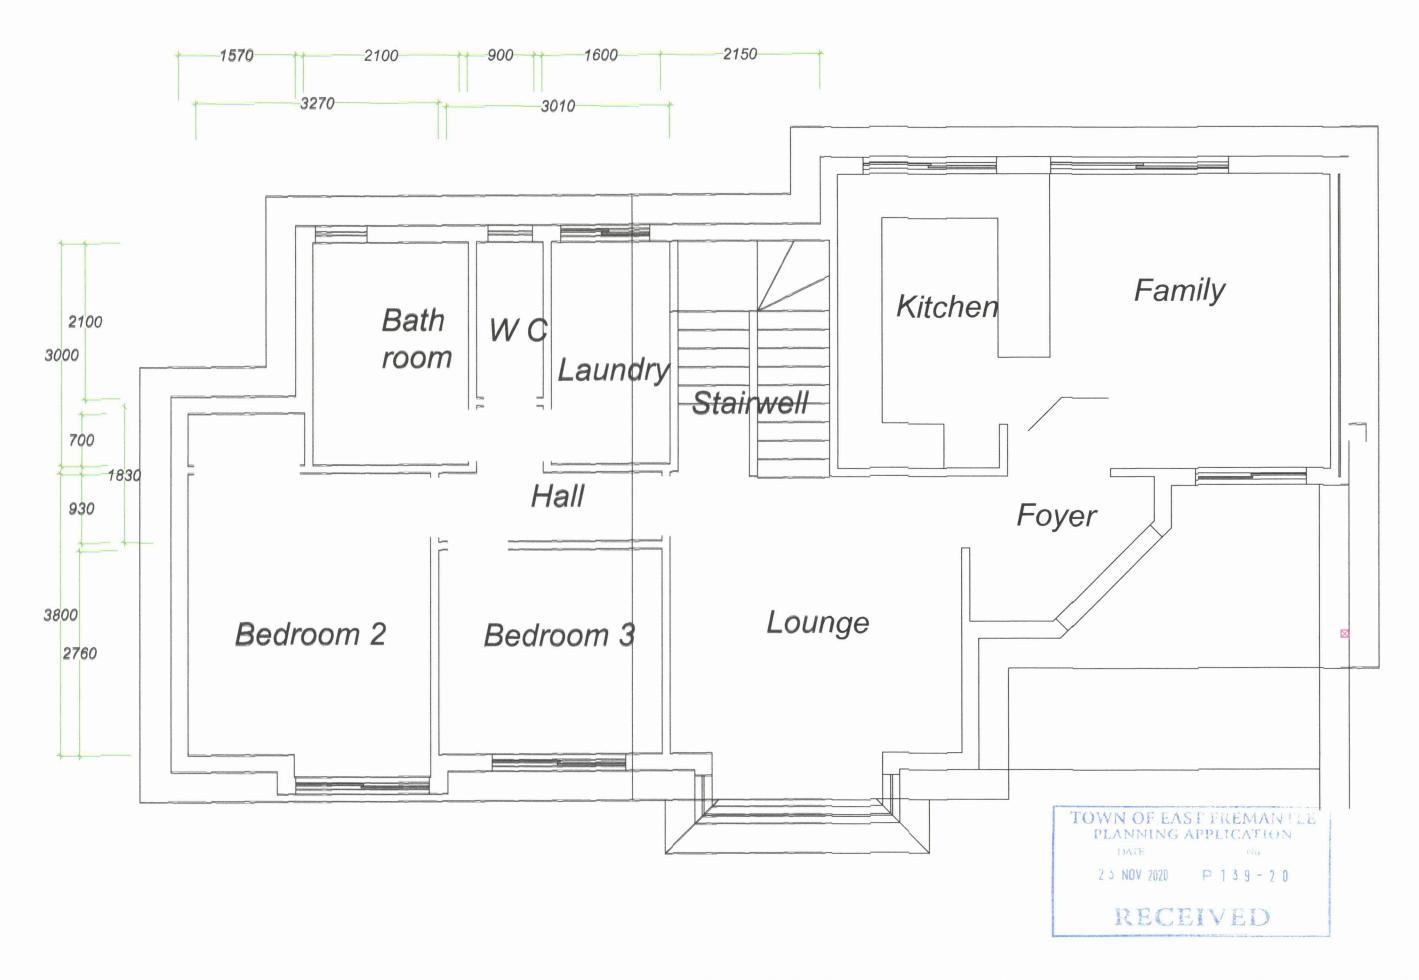

SINGING	DESIGN.		GUENT.	PROPOSED ALTERATIONS	Ground Floor Dimens	sion
8	Paul L. White 4 / 29 McNicholl St. Rockingham WA 6168	A 9th Manyampar 2009 Intelled Department 8 15eth Alexandred 2009 Oreasing a co-upol for scale, 1 50 C	Lacey & Adam Filipich 2 Easton Street	PROPOSED ALTERATIONS 2 Easton Street	PLW 1 : 50	9 15th Nayember 2020
	Phone :0418 151 666 Emall : singsaw94@bigpend.com		East Fremantle	East Fremantle	708 . 01 - 2	20 B